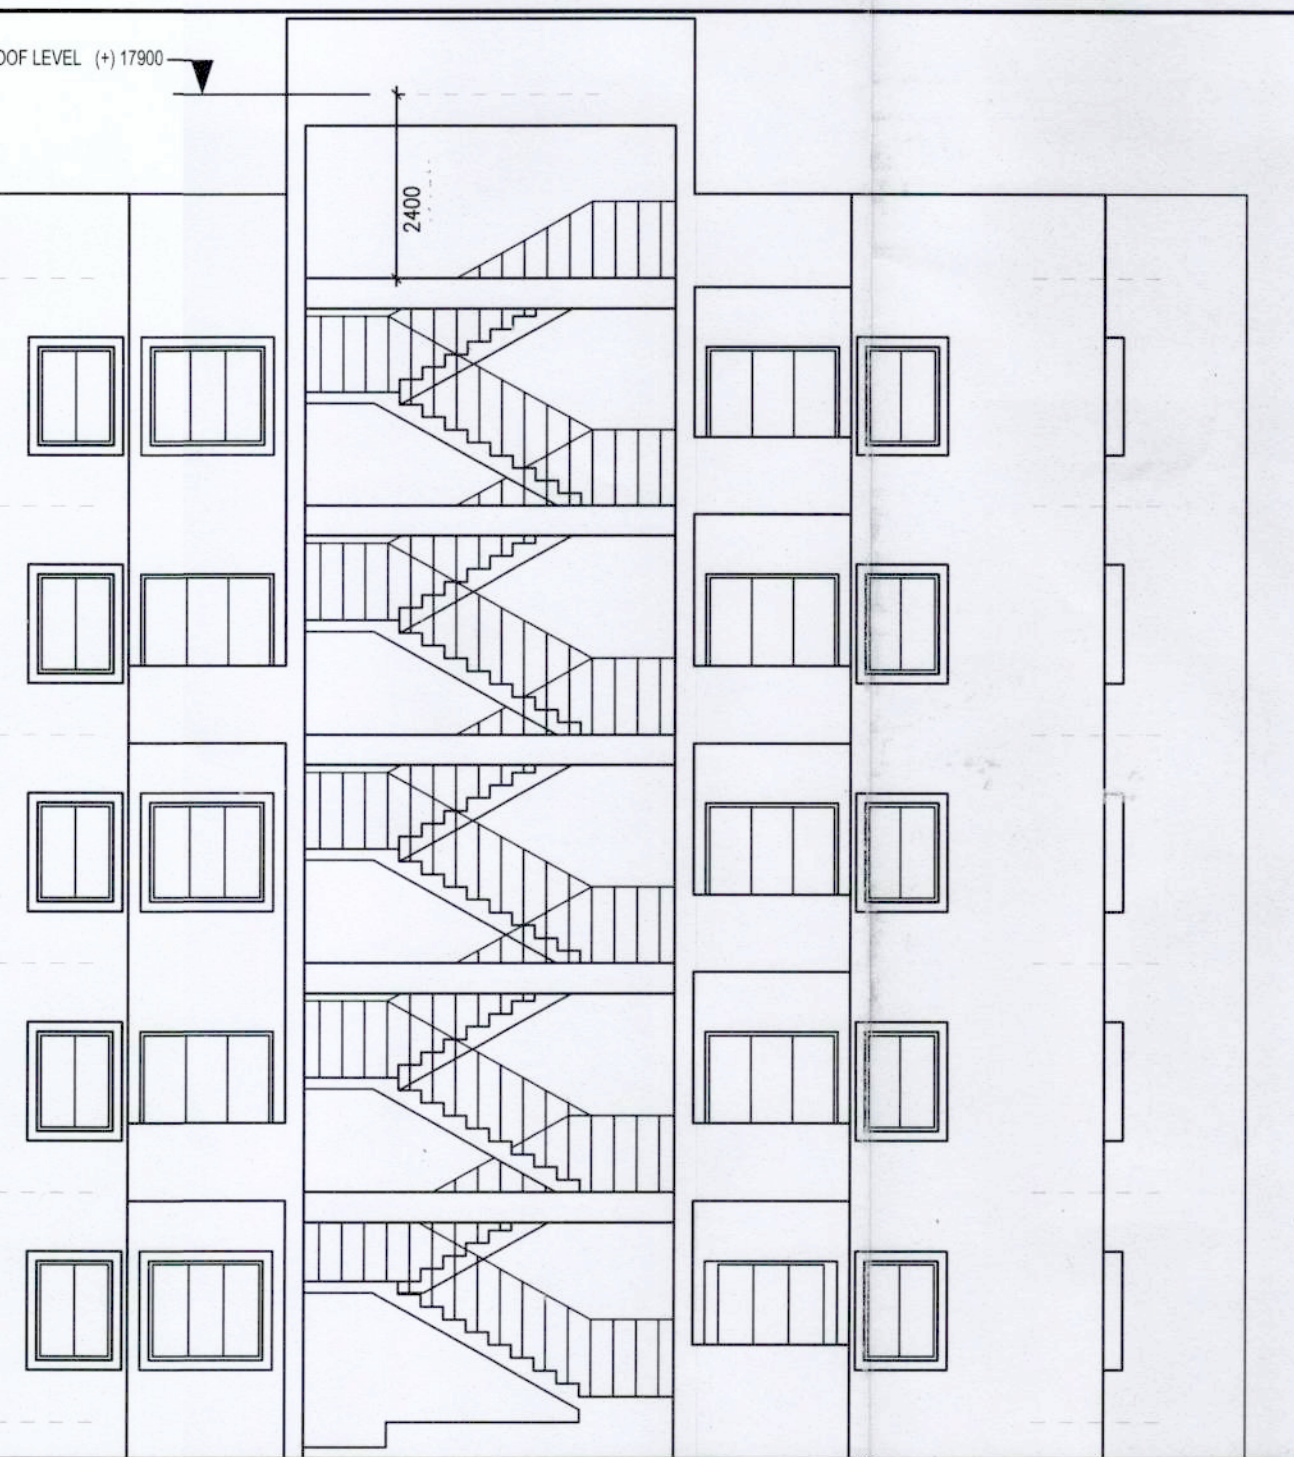
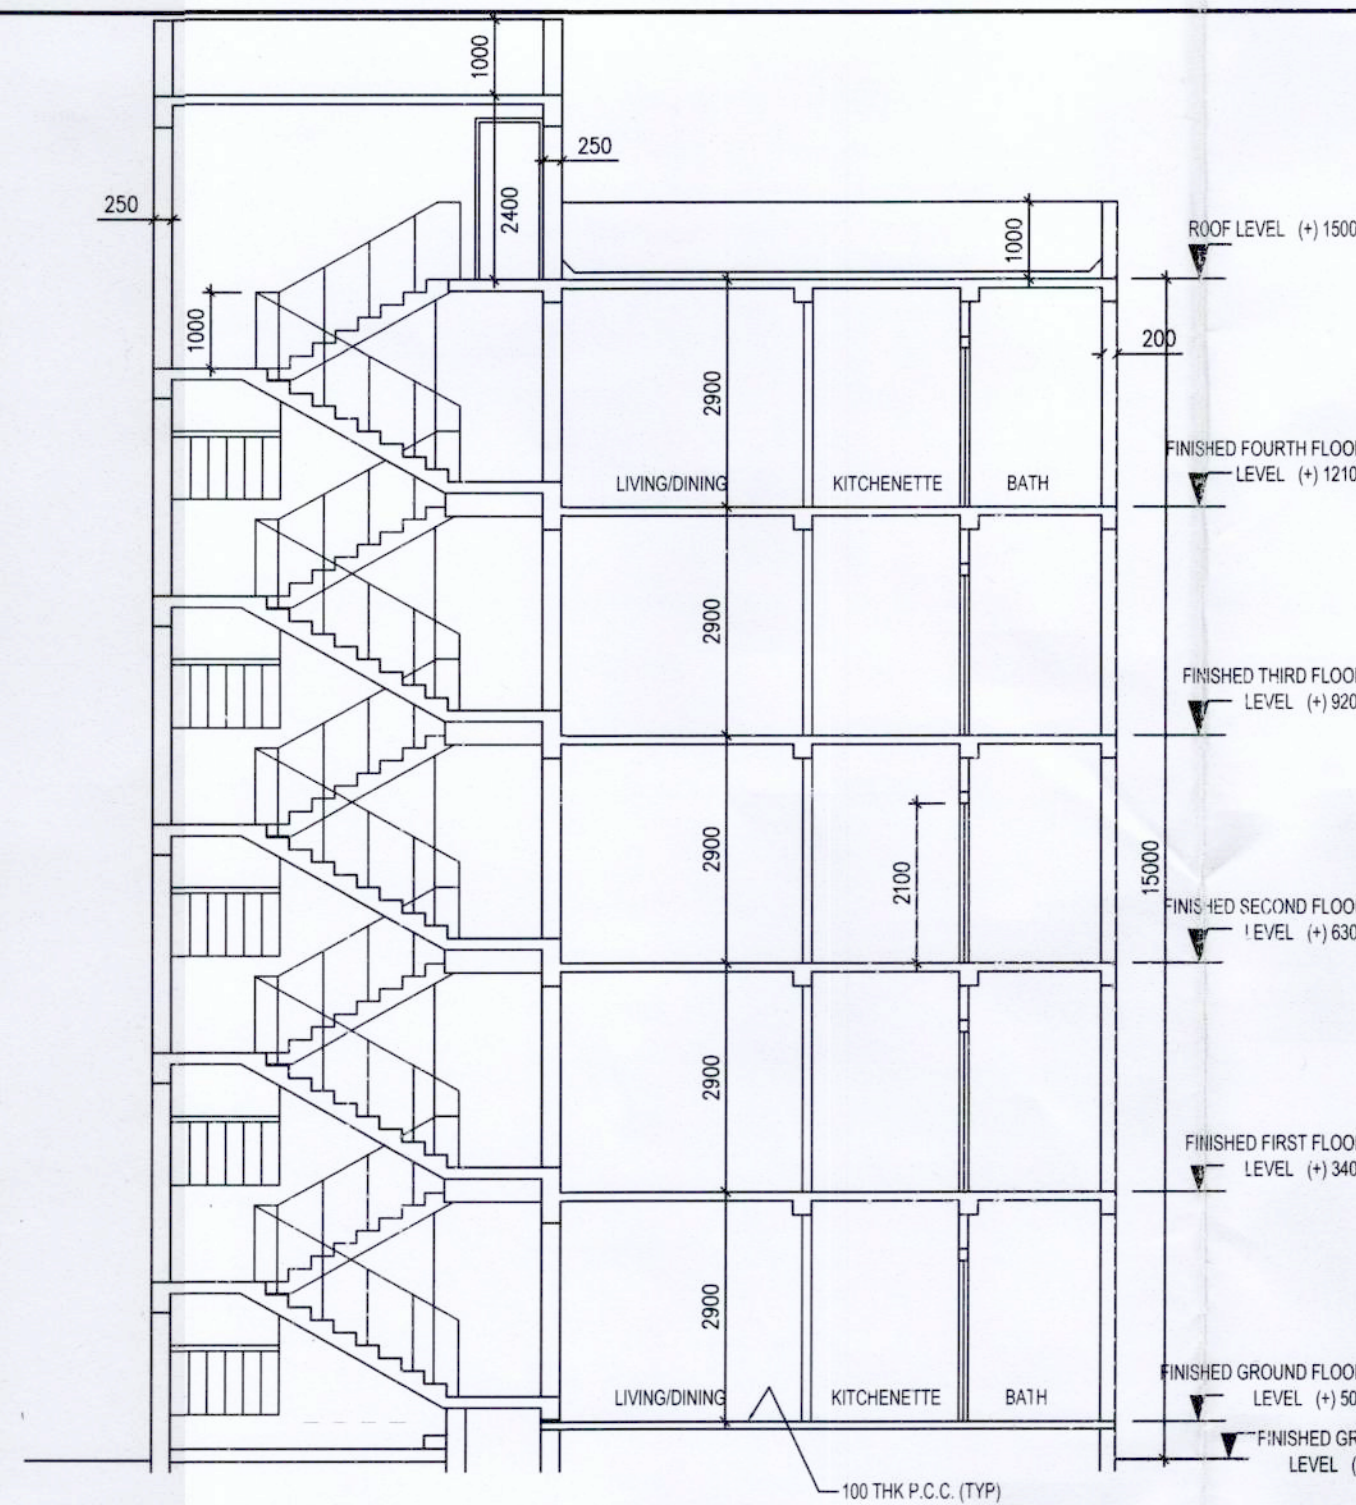


SECTION Y-Y

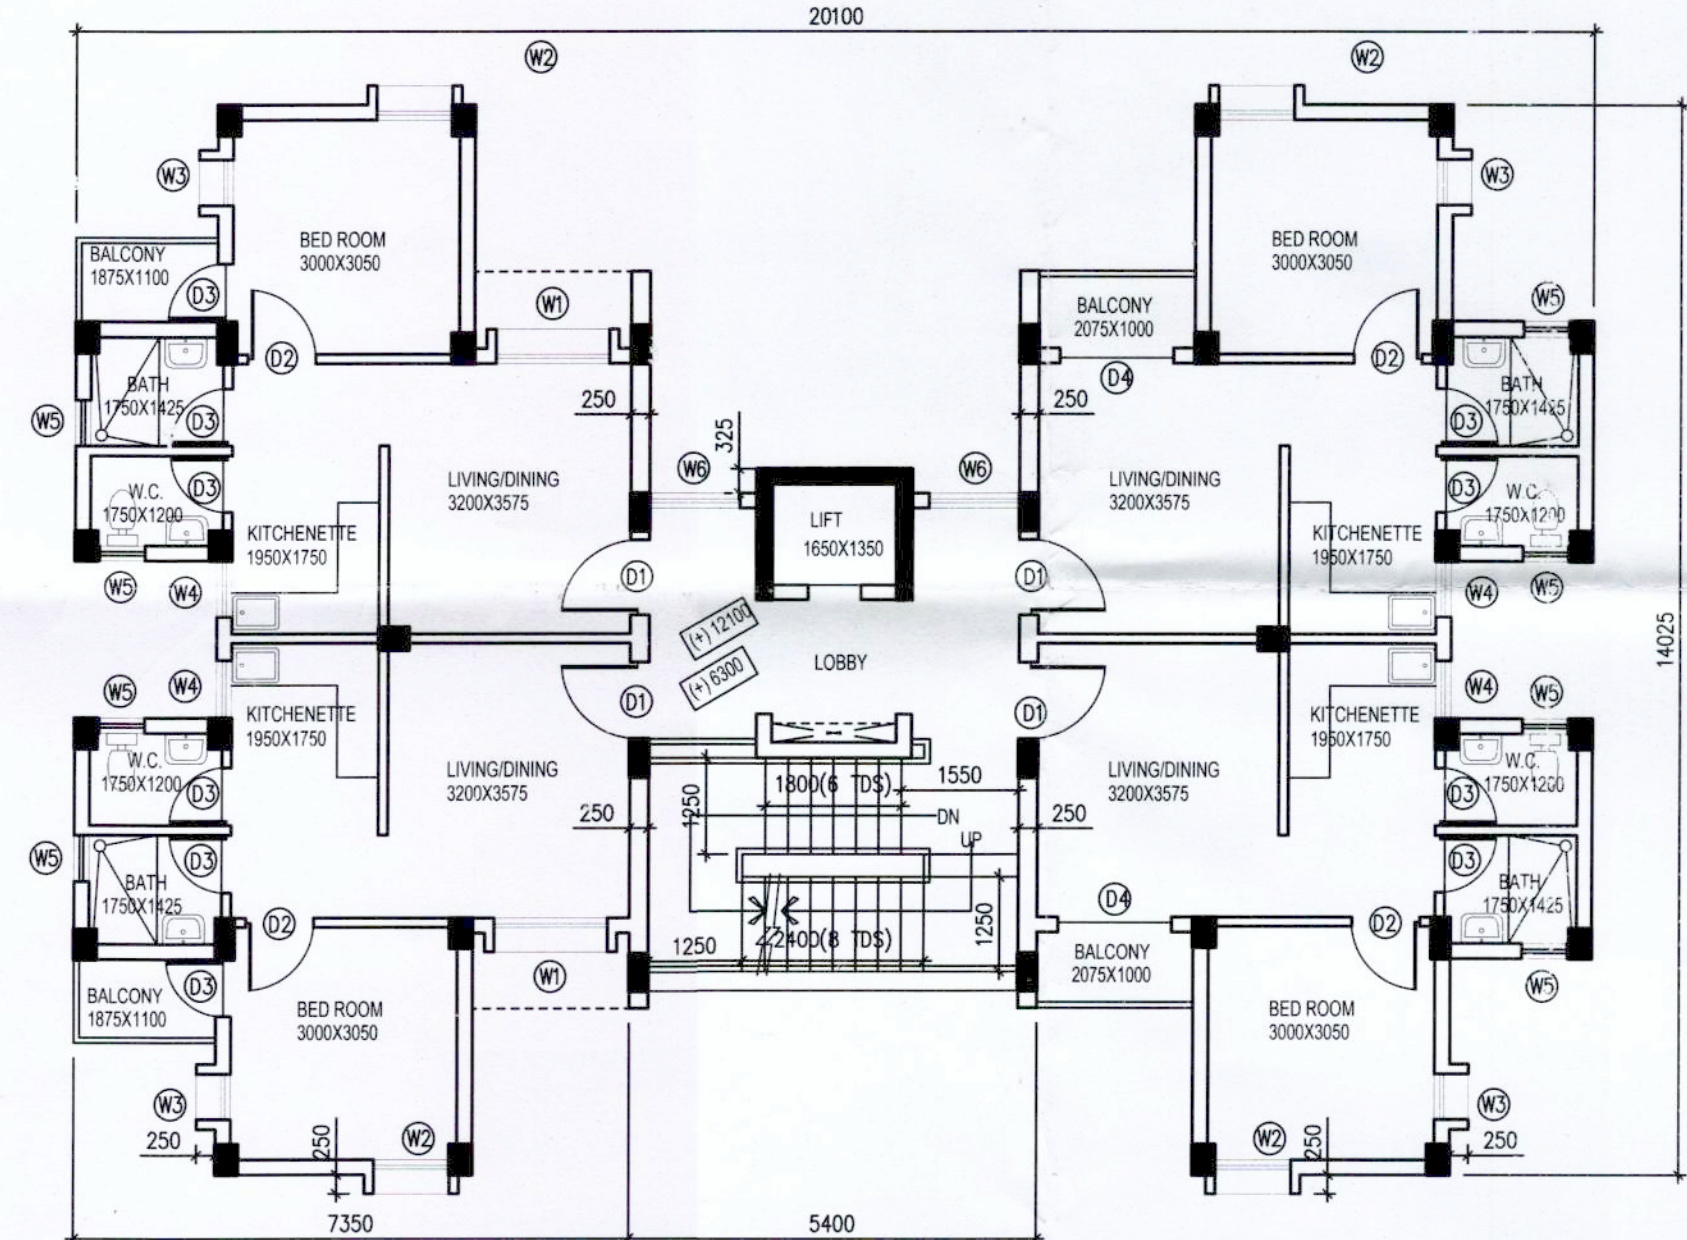
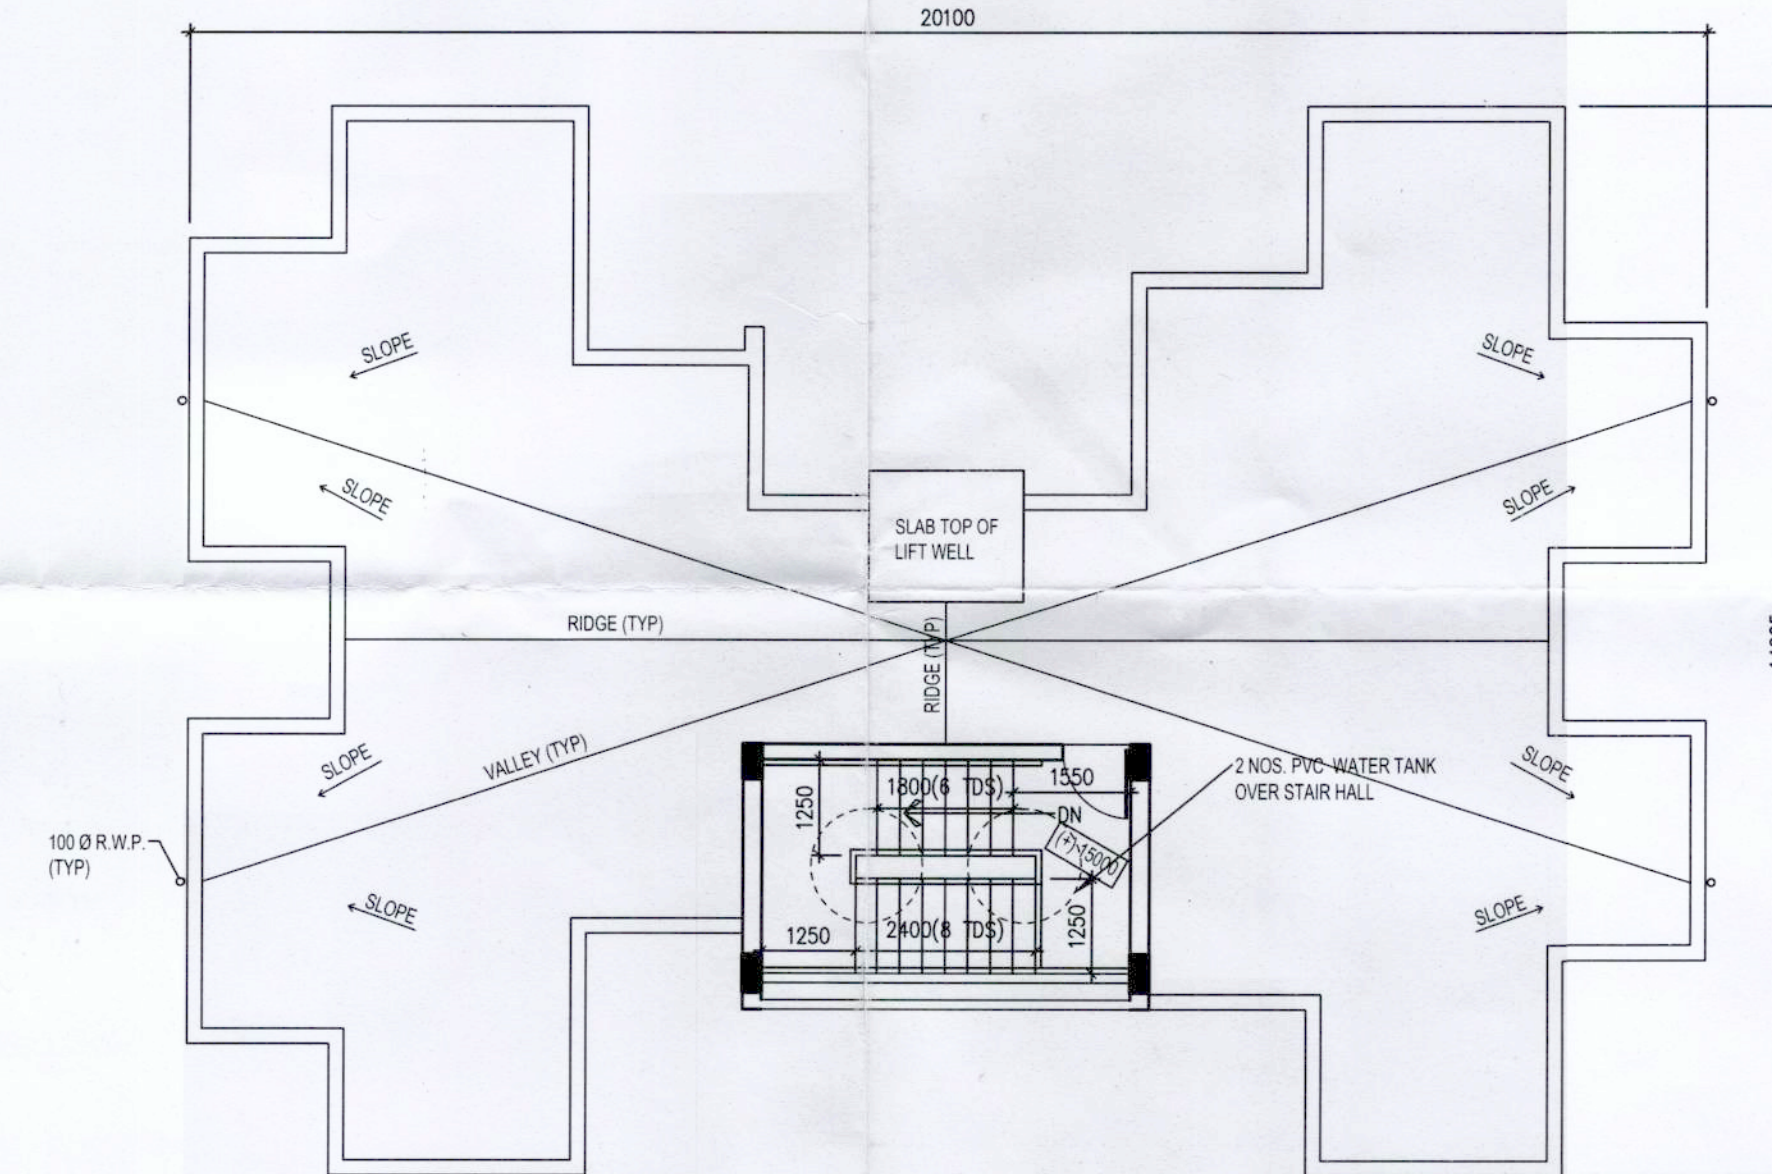
STAIR ROOF LEVEL (+1.780)



FRONT ELEVATION



SECTION X-X

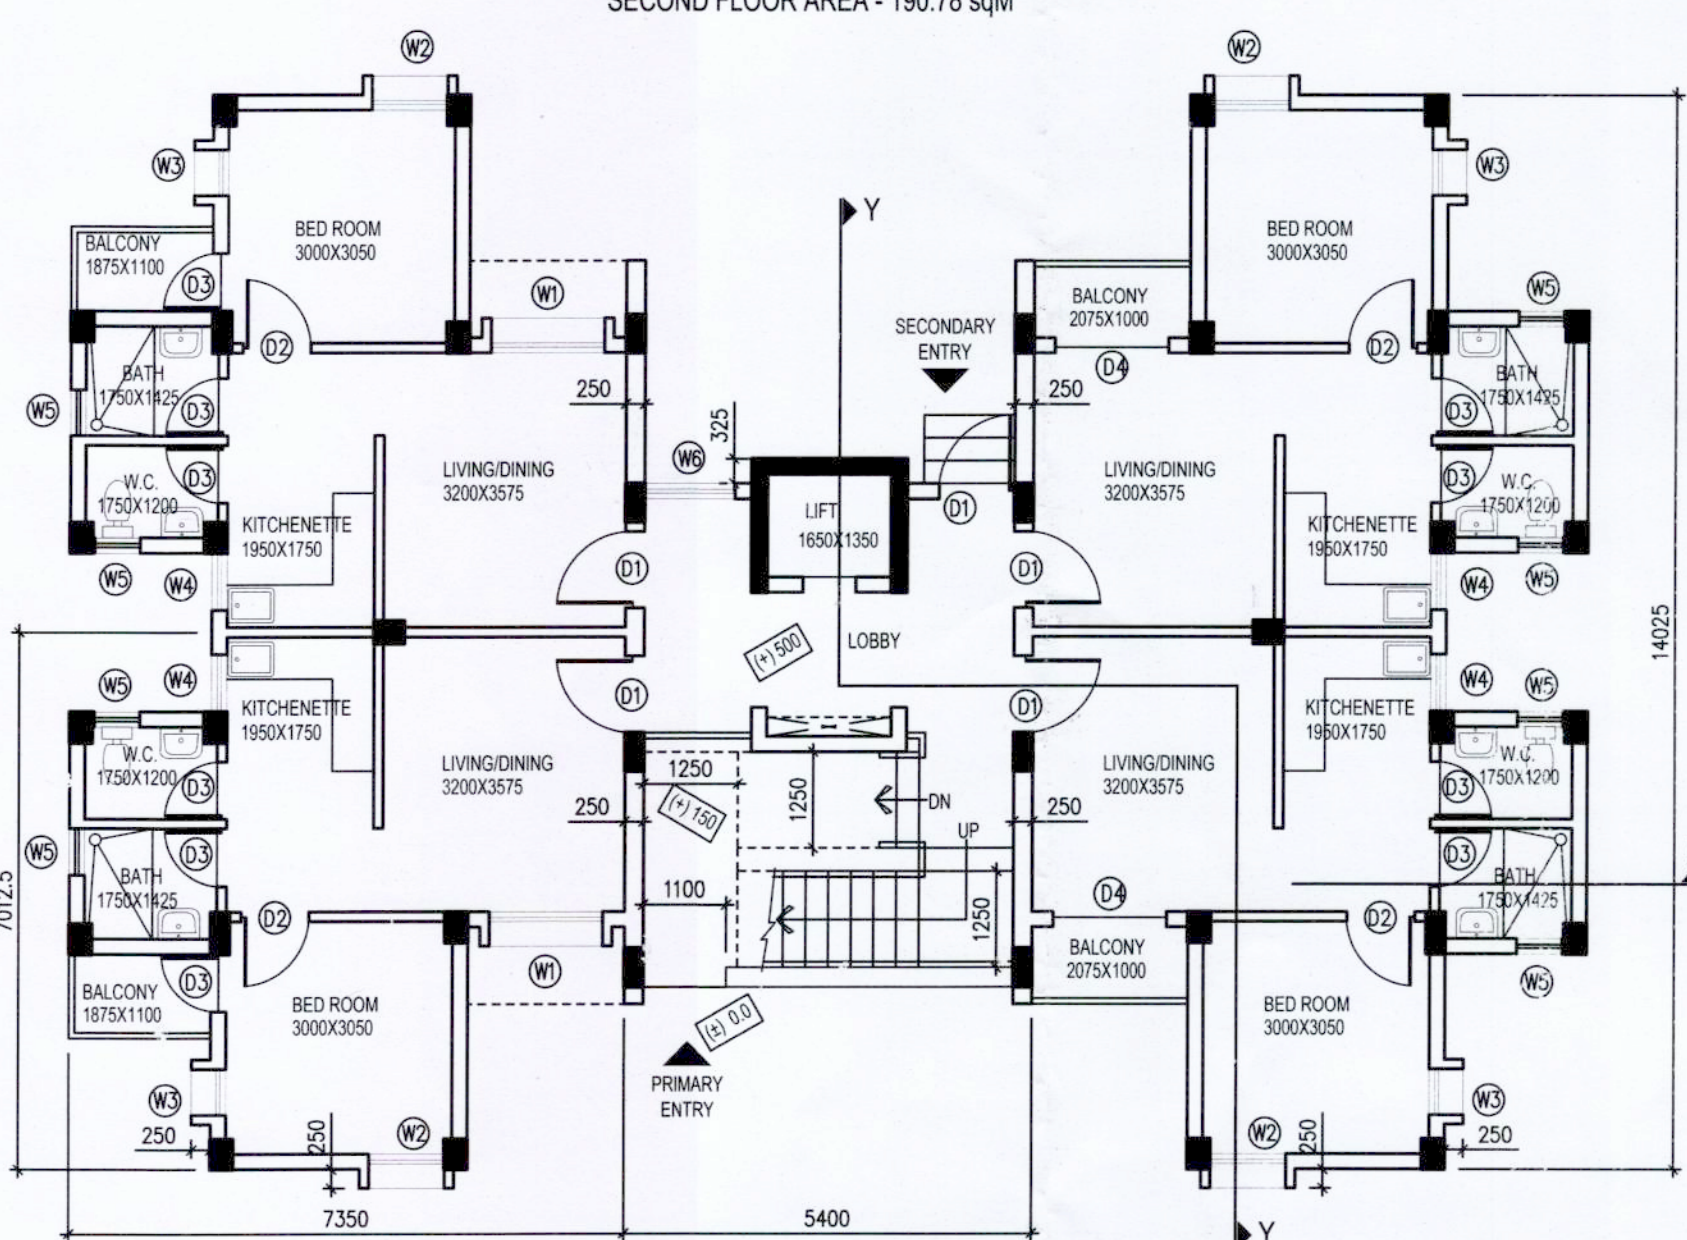
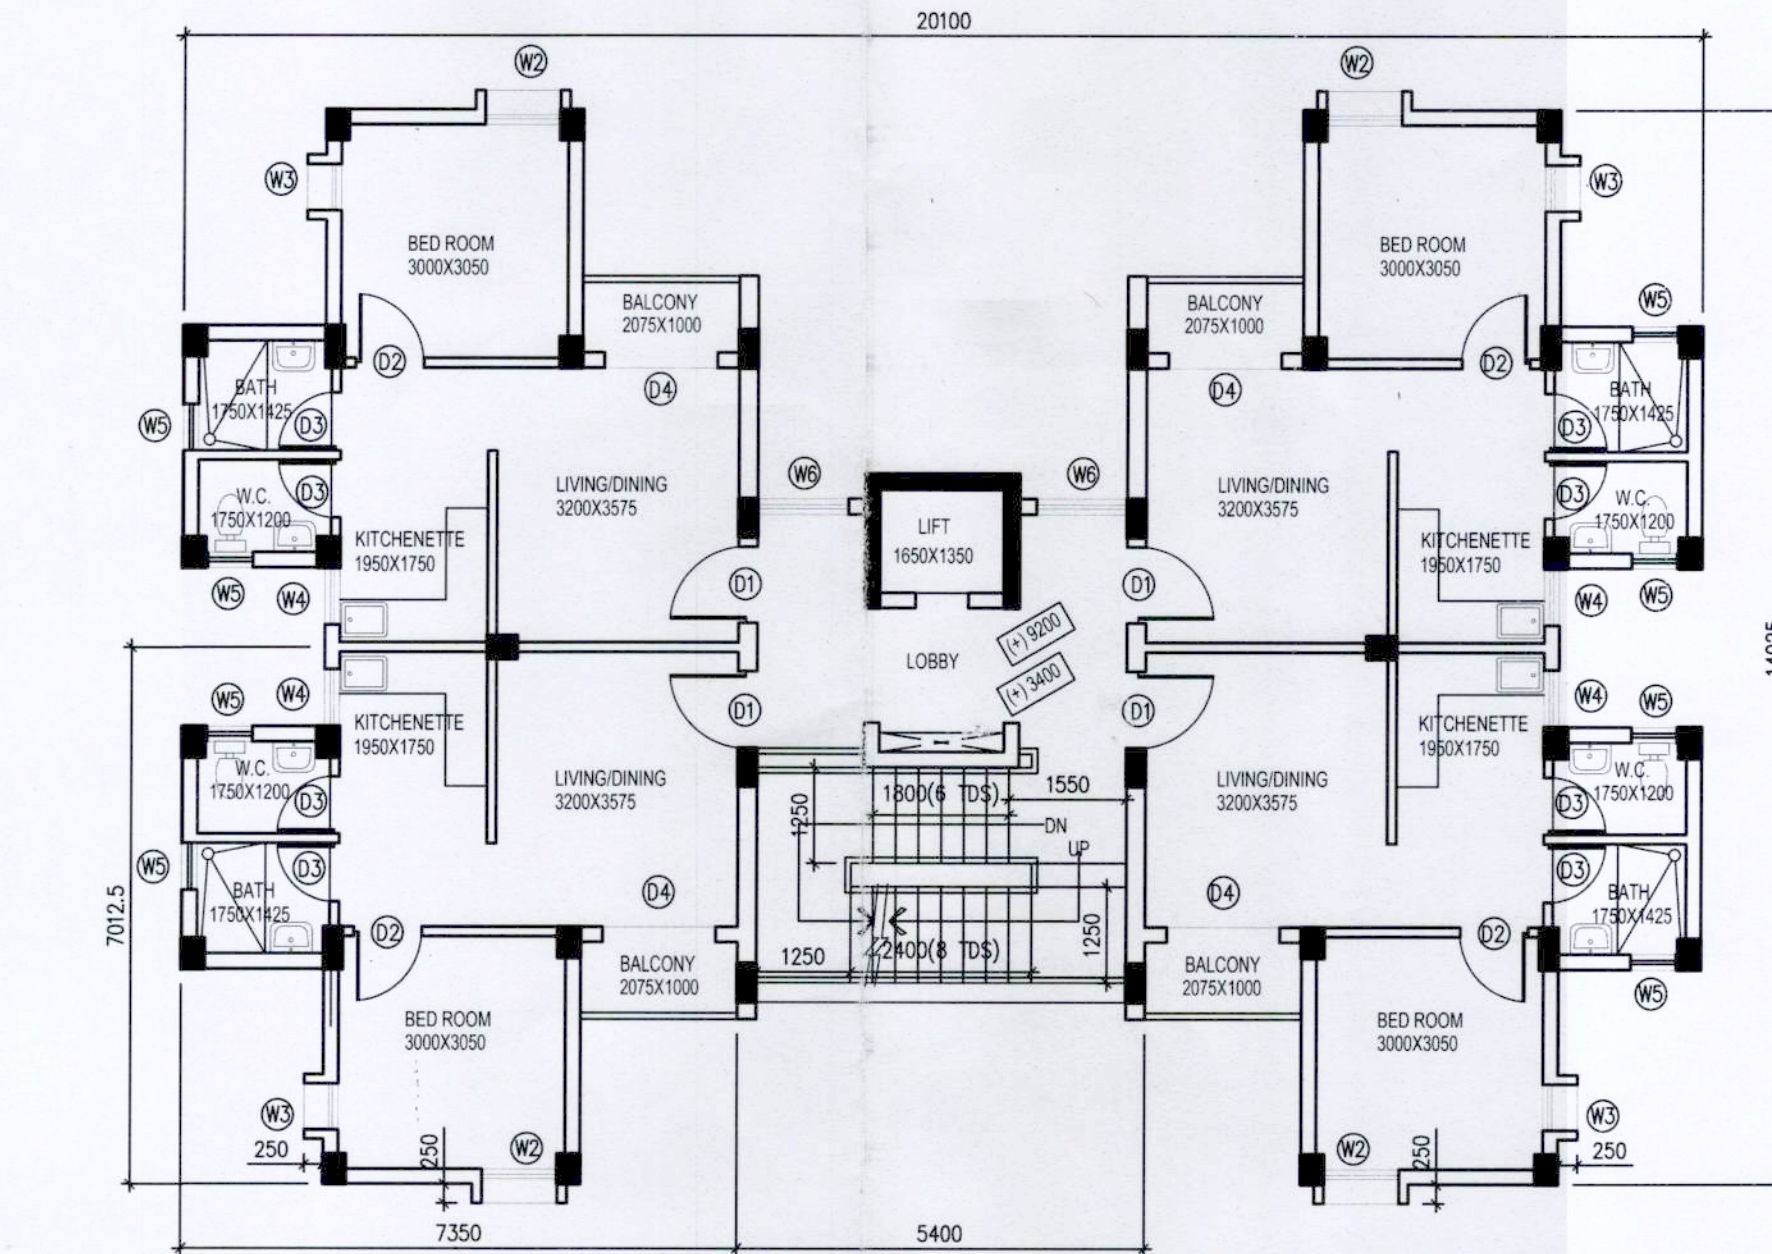
SECOND & FOURTH FLOOR PLAN
SECOND FLOOR AREA - 190.78 sqMROOF PLAN
MUMTY AREA - 18.02 sqM

WINDOW SCHEDULE

TYPE	MASONRY OPENING		REMARKS
	WIDTH (mm)	HEIGHT (mm)	
W1	1500	1300	GLAZED OPENABLE
W2	1000	1300	GLAZED OPENABLE
W3	600	1300	GLAZED OPENABLE
W4	750	1100	GLAZED OPENABLE
W5	600	900	GLAZED OPENABLE
W6	1200	1300	GLAZED OPENABLE

DOOR SCHEDULE

TYPE	MASONRY OPENING		REMARKS
	WIDTH (mm)	HEIGHT (mm)	
D1	1000	2100	
D2	900	2100	
D3	750	2100	
D4	1500	2100	

GROUND FLOOR PLAN
GROUND FLOOR AREA - 193.72 sqMFIRST & THIRD FLOOR PLAN
FIRST FLOOR AREA - 190.8 sqM

GENERAL NOTES :

- ALL DIMENSIONS ARE IN MM UNLESS NOTED OTHERWISE. DIMENSIONS SHALL NOT BE SCALED. ONLY WRITTEN DIMENSIONS SHALL BE FOLLOWED.
- DRAWING SHALL BE READ IN CONJUNCTION WITH SPECIFICATIONS, SCHEDULE OF ITEMS & CONDITIONS AND OTHER RELEVANT DRAWINGS. ANY DISCREPANCY FOUND BETWEEN STRUCTURAL & ARCHITECTURAL OR OTHER SERVICES DRAWINGS SHALL BE BROUGHT TO THE NOTICE OF THE ENGINEER-IN-CHARGE AND GOT RECONCILED BEFORE EXECUTION.
- ALL WALL THICKNESS SHOWN IN DRAWING ARE EXCLUSIVE OF ANY FINISH.
- ALL EXTERNAL & INTERNAL WALLS SHALL BE 200 THK. & 125 THK. RESPECTIVELY, UNLESS OTHERWISE MENTIONED.
- 40 THK FLOOR FINISH SHALL BE PROVIDED OVER 100 THK P.C.C. IN GROUND FLOOR & ALL R.C.C. FLOOR IN ABOVE.
- ALL EXTERNAL & INTERNAL PLASTER SHALL BE 20 MM & 15 MM THK. RESPECTIVELY, AND CEILING PLASTER SHALL BE 10MM, UNLESS OTHERWISE MENTIONED.
- 40 THK DAMP PROOF COURSE SHALL BE PROVIDED IN GROUND FLOOR ONLY.
- ROOF TREATMENT SHALL BE PROVIDED WITH APPROVED WATER PROOFING ADMIXTURES WITH A SLOPE OF 1 : 100 UNLESS OTHERWISE SPECIFIED.

REFERENCE DRAWINGS :

RELEVANT ALL ARCHITECTURAL & OTHERS DRAWINGS.

CERTIFICATE OF THE OWNER / ARCHITECT:

THE BUILDING PLAN HAS BEEN DRAWN AS PER PROVISION OF LATEST WB MUNICIPAL BUILDING RULES THAT THE SITE CONDITION INCLUDING THE WIDTH OF THE ADJUTING ROADS CONFORM WITH THE PLAN & THE SITE IS BUILDABLE SITE & NOT TANK OR FILLED UP LAND. THE SITE PLAN IS CORRECT.

Shibabrata Lai, B.Arch
Architect
COA Reg No-CA/2007/40531
SHIBABRATA LAI
ARCHITECT
COUNCIL OF ARCHITECTURE (REG. NO. CA/2007/40531)
SIGNATURE OF ARCHITECT/L.B.S.

THE STRUCTURAL DESIGN AND DRAWING OF BOTH FOUNDATION AND SUPERSTRUCTURE OF THE BUILDING HAS BEEN MADE BY ME, CONSIDERING ALL POSSIBLE LOADS INCLUDING THE SEISMIC LOAD AS PER THE NATIONAL BUILDING CODE & IS CODES OF INDIA AND CERTIFIED THAT IT IS SAFE AND STABLE IN ALL RESPECT.

Utpal Kumar Basu
BE (CIVIL), JU
CHARTERED ENGINEER (INDIA)
THE INSTITUTION OF ENGINEERS INDIA (MEM. NO. M127398-6)
NKDA REGN. NO. : STER/NKDA/23/00026
SIGNATURE OF STRUCTURAL ENGINEER

SIGNATURE OF GEO-TECHNICAL ENGINEER

SIGNATURE & NAME OF THE OWNER/S WITH ADDRESS :

Bengal DCL Housing Development Company Ltd.
Indranil Majumdar
Managing Director

SIGNATURE OF VETTING AUTHORITY:

Acknowledgement No. H89F5338

M. S. 30.7.2025
Assistant Engineer
Hooghly Zilla Parishad

AN
District Engineer
Hooghly Zilla Parishad

SPACE FOR OFFICE USE

LIG (G+4) STORIED
FLOOR PLANS, ELEVATION, SECTIONS & SCHEDULE

PROJECT : SAANVI HOUSING COMPLEX AT RAMNAGAR MOUZA, J.L. NO. 84 & ROSTAMPUR MOUZA, J.L. NO. 87, GHANASHYMPUR, UNDER BARUIPARARA PALTAGARH GRAM PANCHYAT, SINGUR, HOOGHLY

BENGAL DCL HOUSING DEVELOPMENT COMPANY LIMITED
BLOCK 08/4, 2ND FLOOR, SECTOR-11, SALT LAKE CITY, KOLKATA-700 061

DRAWN : SRC REVIEWED : DB SCALE : 1:100
APPROVED : DB DATE : 04-02-25
DWG. NO. 15701-DWG-A-LIG-M001 REV. 0